DEVELOPMENT APPLICATION

DRAWING SCHEDULE

SECTION VIEW

3D VIEWS

FRONT FENCE DETAILS

BASIX COMMITMENTS

NATHERS COMMITMENTS

DRIVEWAY GRADE DETAILS

SHADOW DIAGRAMS - 21st JUNE

IN-GROUND SWIMMING POOL DETAILS LANDSCAPE AREA CALCULATION SHEET

GROSS FLOOR AREA CALCULATION SHEET

SCHEDULE OF EXTERNAL MATERIALS, COLOURS AND FINISHES

10

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14 15

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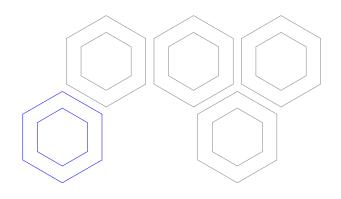
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19 20

SITE ANALYSIS PLAN	01
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ISSUE DETAILS

A 24.07.2024 ISSUED FOR DEVELOPMENT APPLICATION





ADDITIONAL INFORMATION

A01	OWNER'S CONSENT FORM

A02 SURVEY PLAN

A03 BASIX & NATHERS CERTIFICATION

A04 STORMWATER PLAN A05 LANDSCAPE PLAN

A06 STATEMENT OF ENVIRONMENTAL EFFECTS

A07 WASTE MANAGEMENT PLAN
A08 COST SUMMARY REPORT
A09 QUANTITY SURVEYORS REPORT



PROPOSED TWO STOREY DWELLING


38 SAXON STREET, BELFIELD NSW 2191

BILL MALLOUHI






es.au

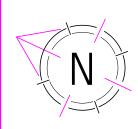



483.1 m²

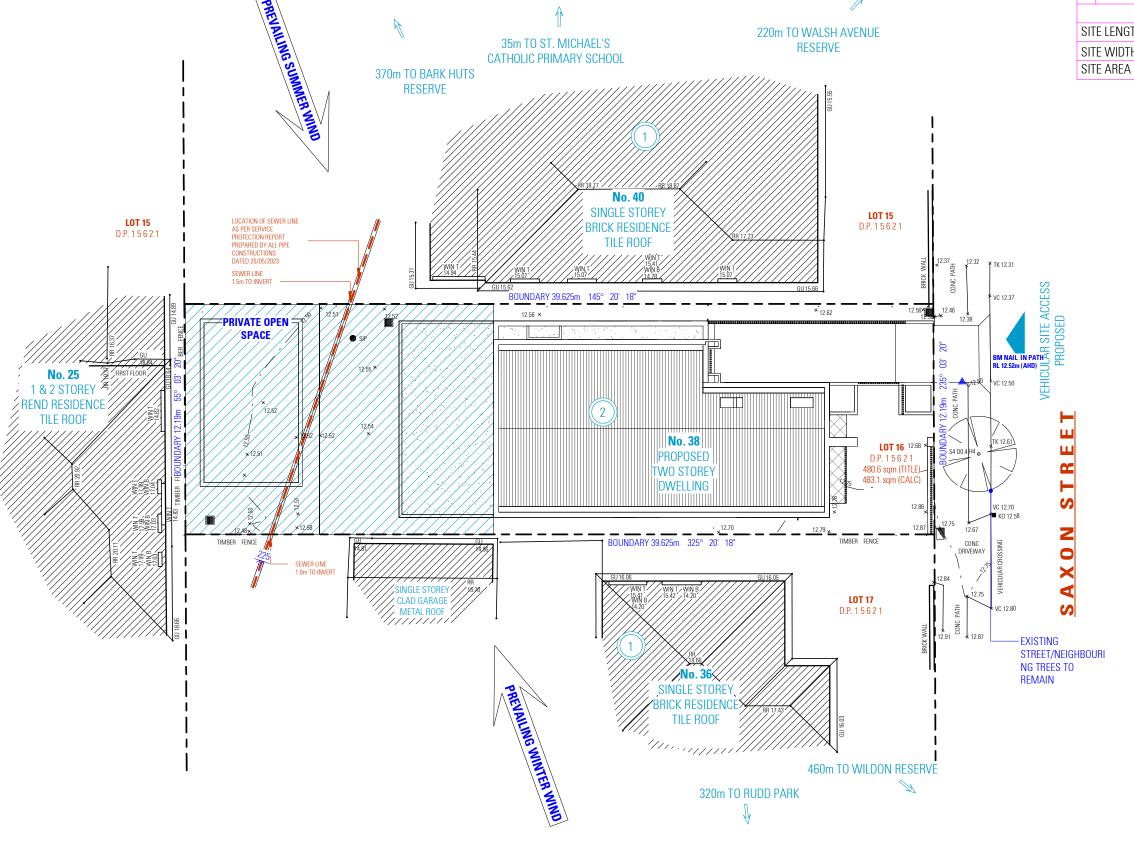

SITE ANALYSIS PLAN

NOT FOR CONSTRUCTION

NOTES

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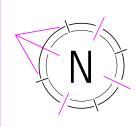


PROPOSED TWO STOREY DWELLING DRAWING

DESIGN CLARE FAULKNER

SITE ANALYSIS PLAN 38 SAXON STREET **BELFIELD NSW 2191**


SCALE 1:200/A3 BILL MALLOUHI ISSUE A 24.07.2024



SITE LEGEND		
	ITEM	SYMBOL
KEY	STRUCTURE TO BE DEMOLISHED	
	ITEMS TO BE REMOVED	[]

DEMOLITION NOTES

- EXISTING VEHICULAR CROSSING TO BE REMOVED, A NEW VEHICULAR CROSSING TO BE CONSTRUCTED TO THE SPECIFICATIONS OF COUNCIL
- ALL DEMOLITION AND WASTE MATERIALS TO BE REMOVED FROM SITE IN ACCORDANCE WITH THE ACCOMPANYING WASTE MANAGEMENT PLAN, AND AUSTRALIAN STANDARD 2601.2001
- ALL NECESSARY PERMITS ARE TO BE OBTAINED FROM COUNCIL BY THE NOMINATED CONTRACTOR PRIOR TO ANY WORKS
- ANY HAZARDOUS MATERIAL FOUND ON SITE IS TO BE REMOVED IN ACCORDANCE WITH RELEVANT LEGISLATION, BUILDING CODES, AUSTRALIAN STANDARDS AND WORK COVER GUIDELINES.

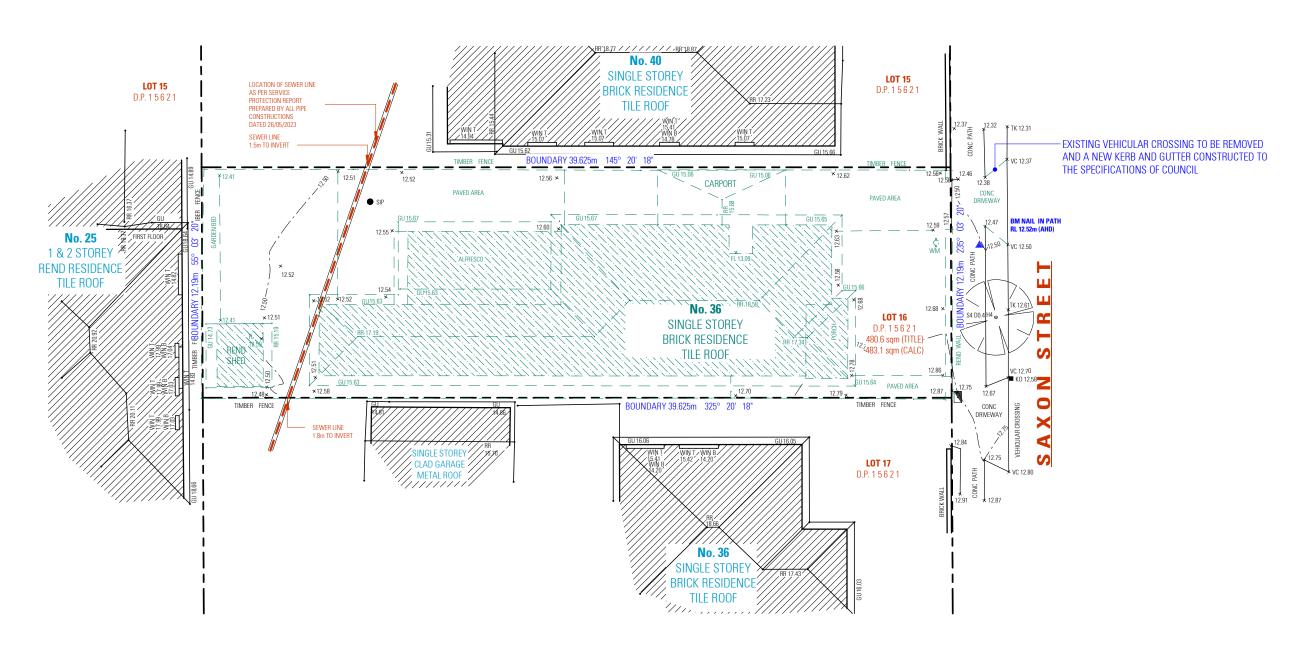

DEMOLITION PLAN

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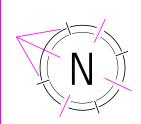
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DESIGN CLARE FAULKNER

DRAFTED IRENA MILOJESKA


DEMOLITION PLAN 38 SAXON STREET

BELFIELD NSW 2191 SCALE 1:200/A3 BILL MALLOUHI ISSUE



- REFER TO LANDSCAPE PLAN FOR DETAILS
- REFER TO STORMWATER PLAN FOR STORMWATER DETAILS / SEDIMENT AND EROSION CONTROL PLAN
- REFER TO STRUCTURAL PLAN FOR RETAINING WALL DETAILS
- REFER TO STORMWATER PLAN AND BASIX REPORT FOR RAINWATER TANK DETAILS
- ALL BOUNDARY FENCING TO BE MAINTAINED OR CONSTRUCTED AT A HEIGHT OF 1800mm ABOVE NGL

SITE CALCULATION	VS
SITE AREA	483.1 sqm
GROUND FLOOR AREA	131.24sqm
FIRST FLOOR AREA	115.76sqm
TOTAL FLOOR AREA	247.00sqm
FLOOR SPACE RATIO	0.51:1
MAX FLOOR SPACE RATIO	0.55:1
SITE COVERAGE	215.83 sqm
MAX SITE COVERAGE (50%)	241.55sqm
IMPERVIOUS AREA	338.43sqm
DEEP SOIL AREA	105.81sqm
MIN DEEP SOIL AREA 20%	96.62sqm

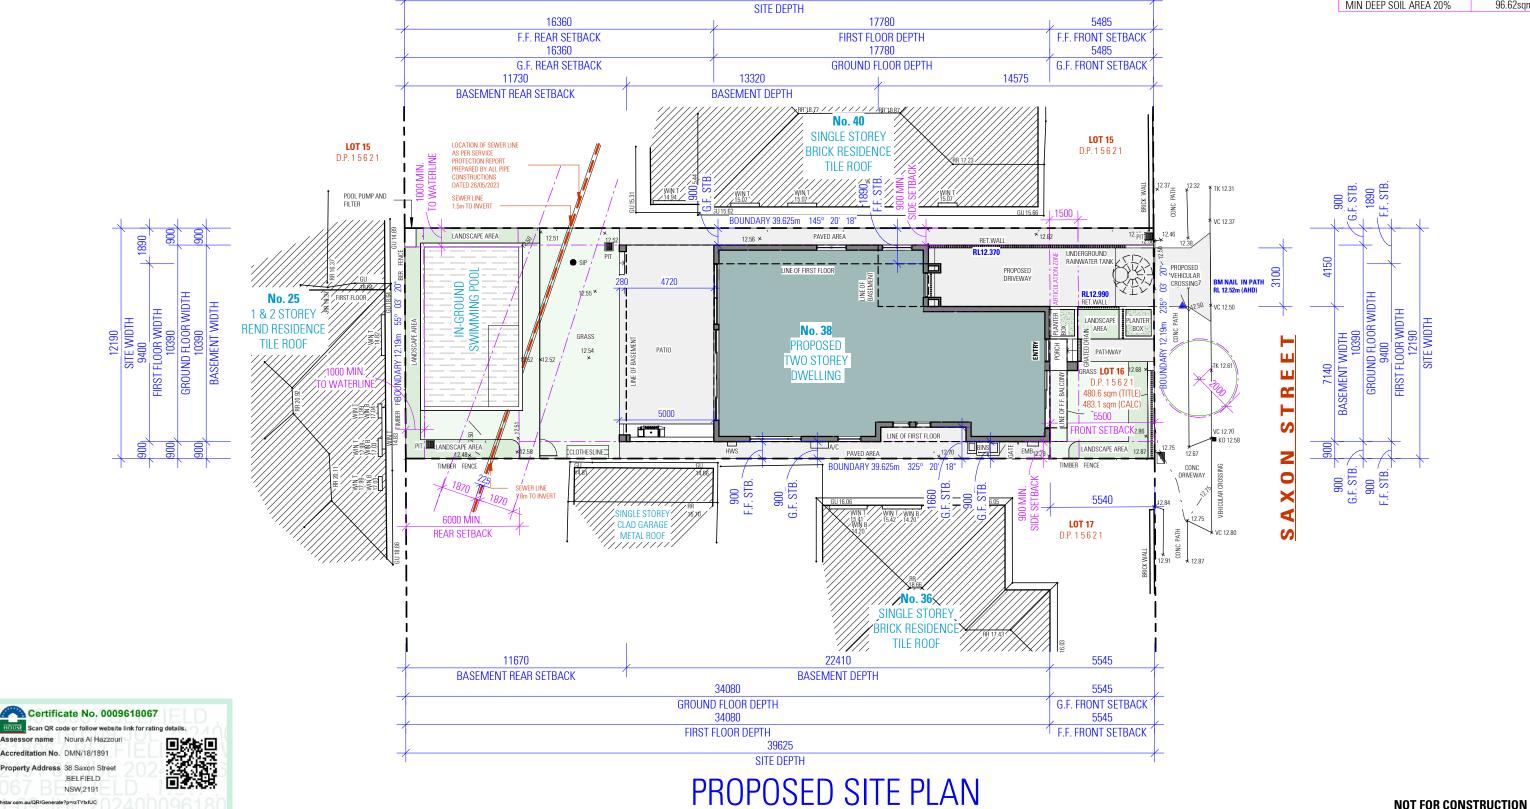

39625

Accreditation No. DMN/18/1891 BELFIELD NSW,2191

SITE LEGEND

ITEM

GROUND FLOOR AREA

LINE OF FIRST FLOOR

SITE BOUNDARY

SYMBOL

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PROPOSED SITE PLAN 38 SAXON STREET

BELFIELD NSW 2191

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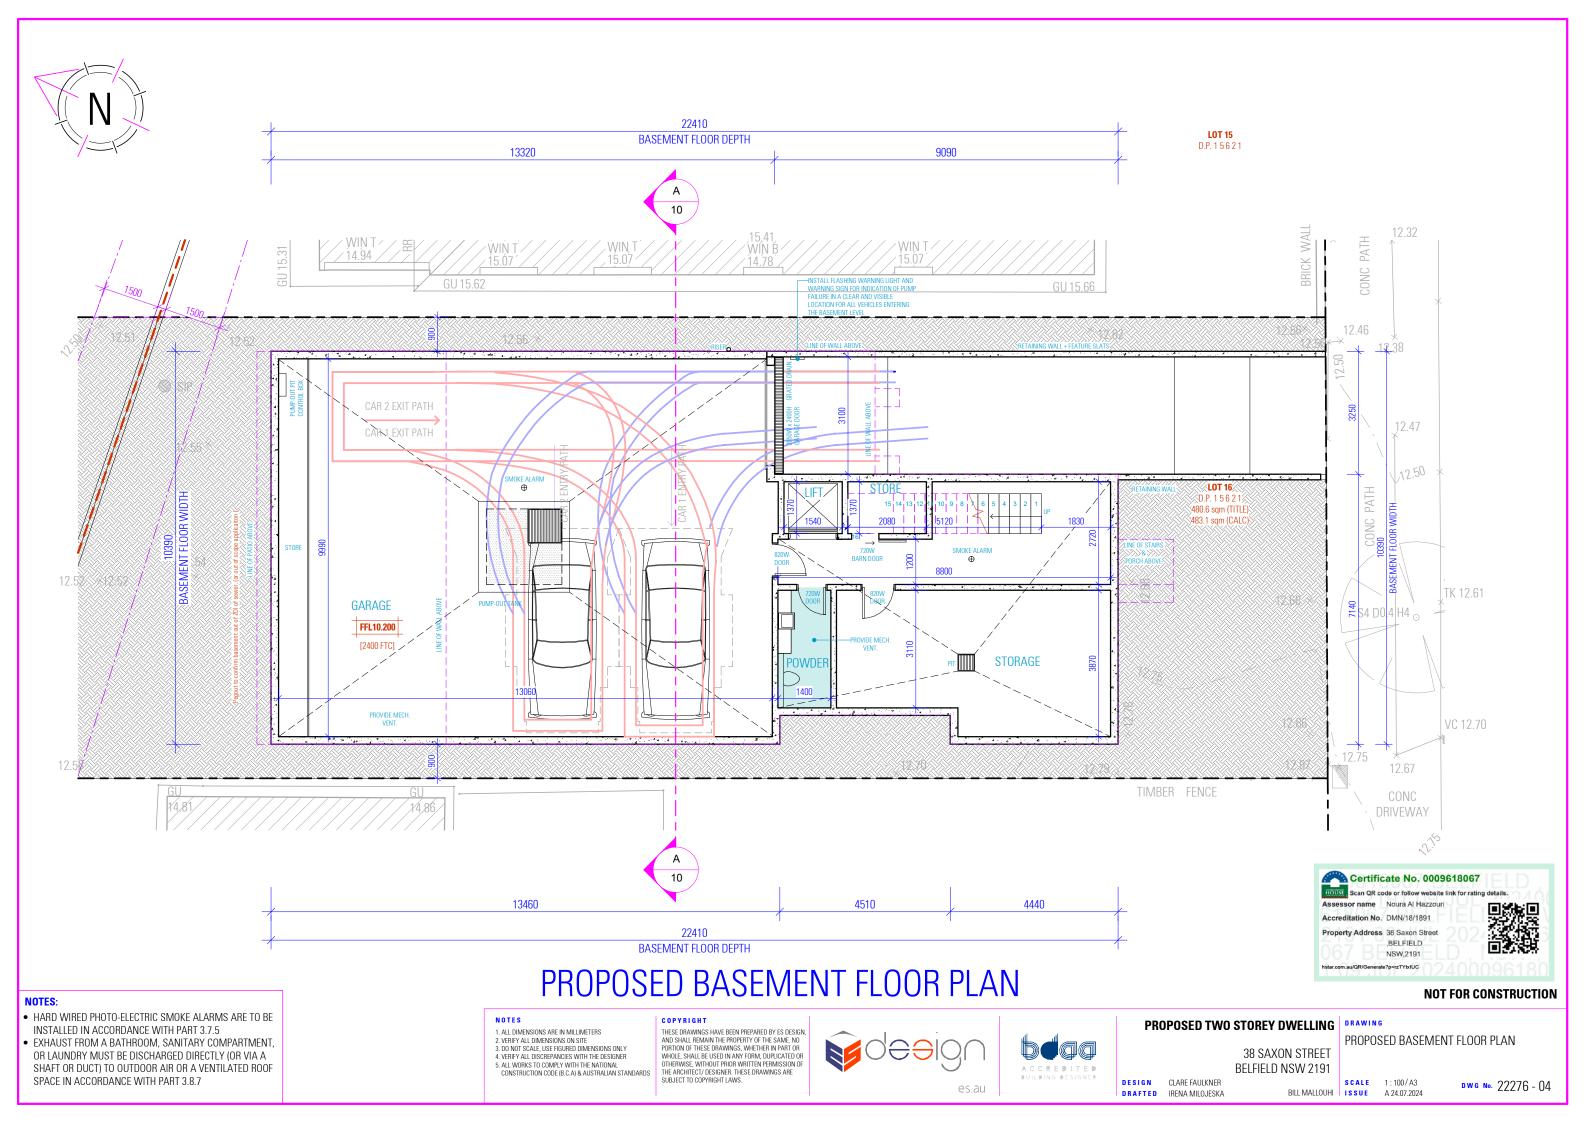
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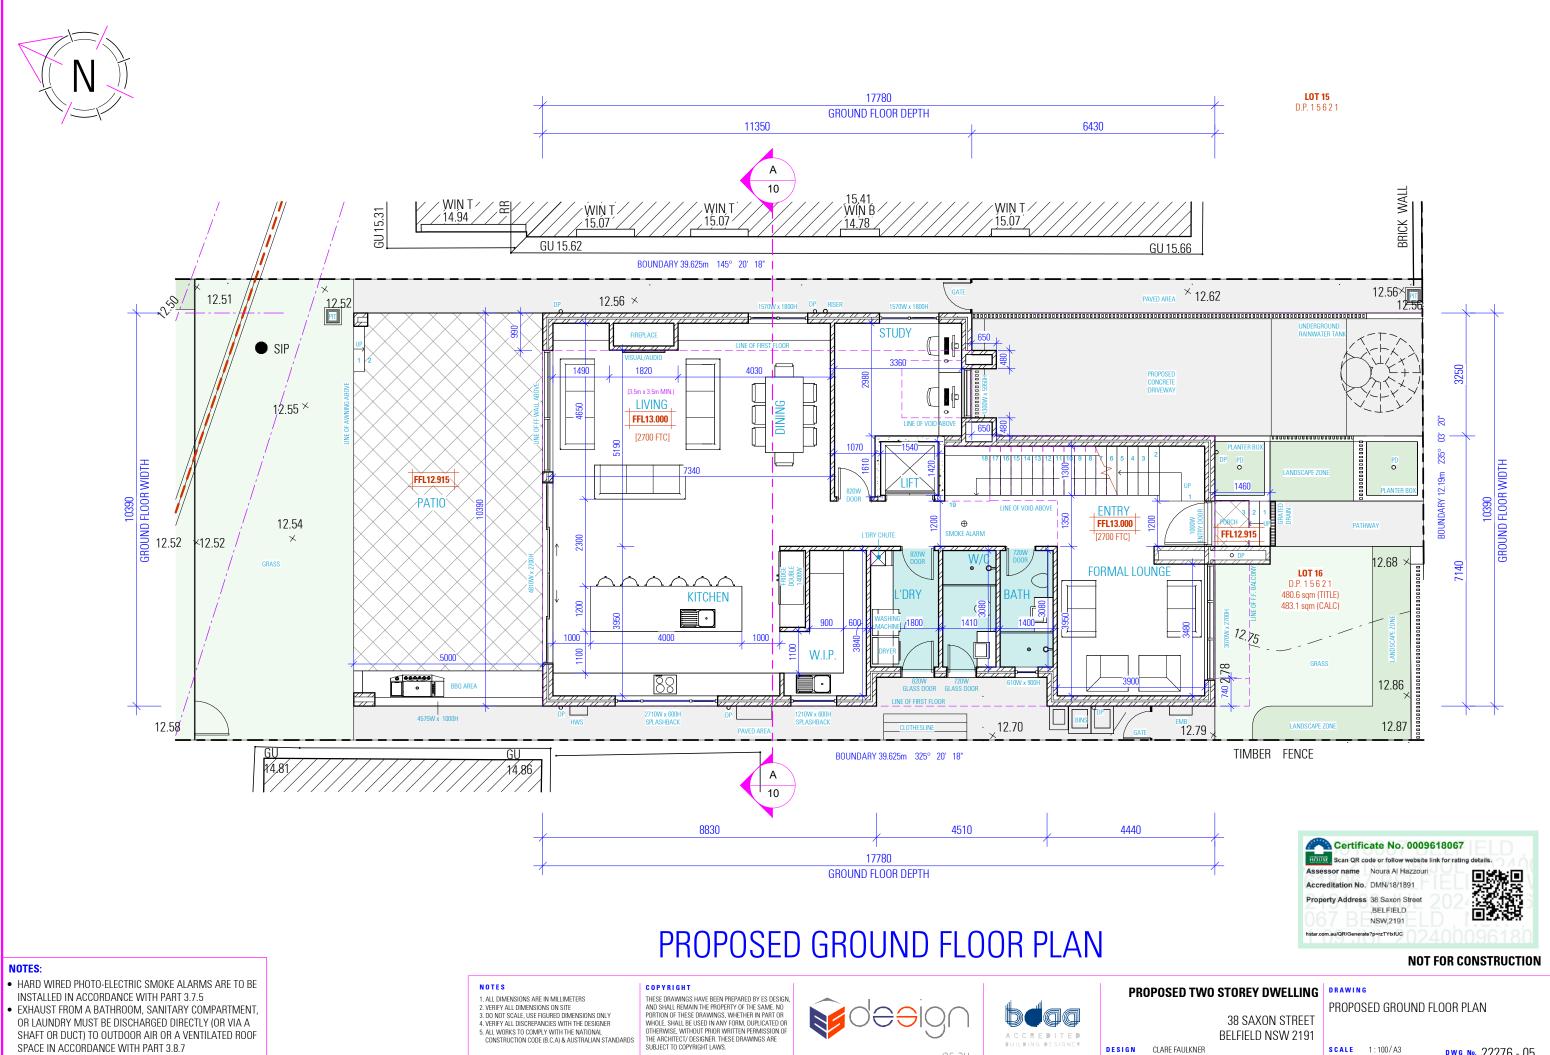
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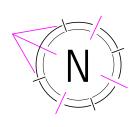
SHAFT OR DUCT) TO OUTDOOR AIR OR A VENTILATED ROOF SPACE IN ACCORDANCE WITH PART 3.8.7




BELFIELD NSW 2191

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- HARD WIRED PHOTO-ELECTRIC SMOKE ALARMS ARE TO BE INSTALLED IN ACCORDANCE WITH PART 3.7.5
- EXHAUST FROM A BATHROOM, SANITARY COMPARTMENT, OR LAUNDRY MUST BE DISCHARGED DIRECTLY (OR VIA A SHAFT OR DUCT) TO OUTDOOR AIR OR A VENTILATED ROOF SPACE IN ACCORDANCE WITH PART 3.8.7

PROPOSED FIRST FLOOR PLAN

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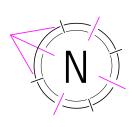
PROPOSED TWO STOREY DWELLING DRAWING

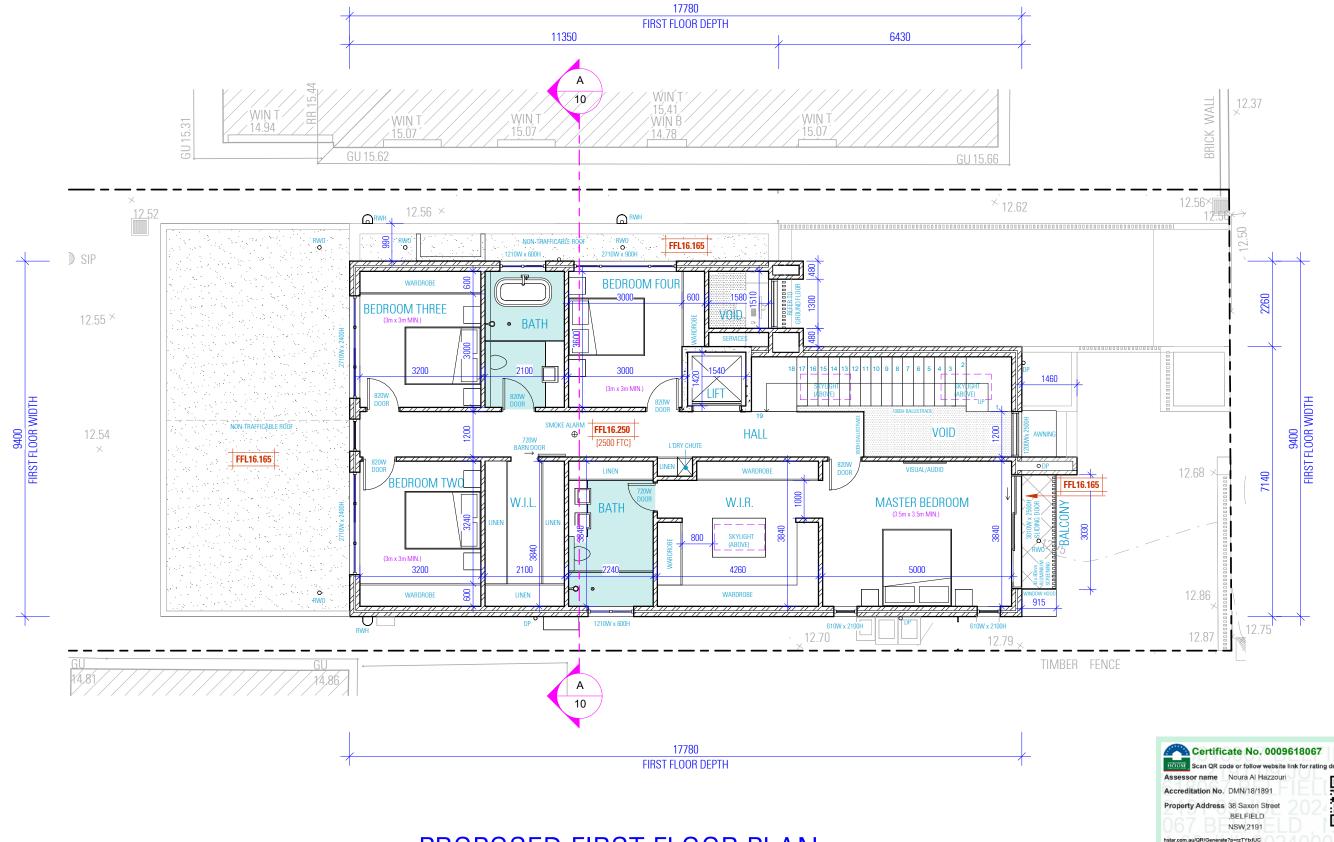
DESIGN CLARE FAULKNER

38 SAXON STREET **BELFIELD NSW 2191**

PROPOSED FIRST FLOOR PLAN

BILL MALLOUHI ISSUE A 24.07.2024



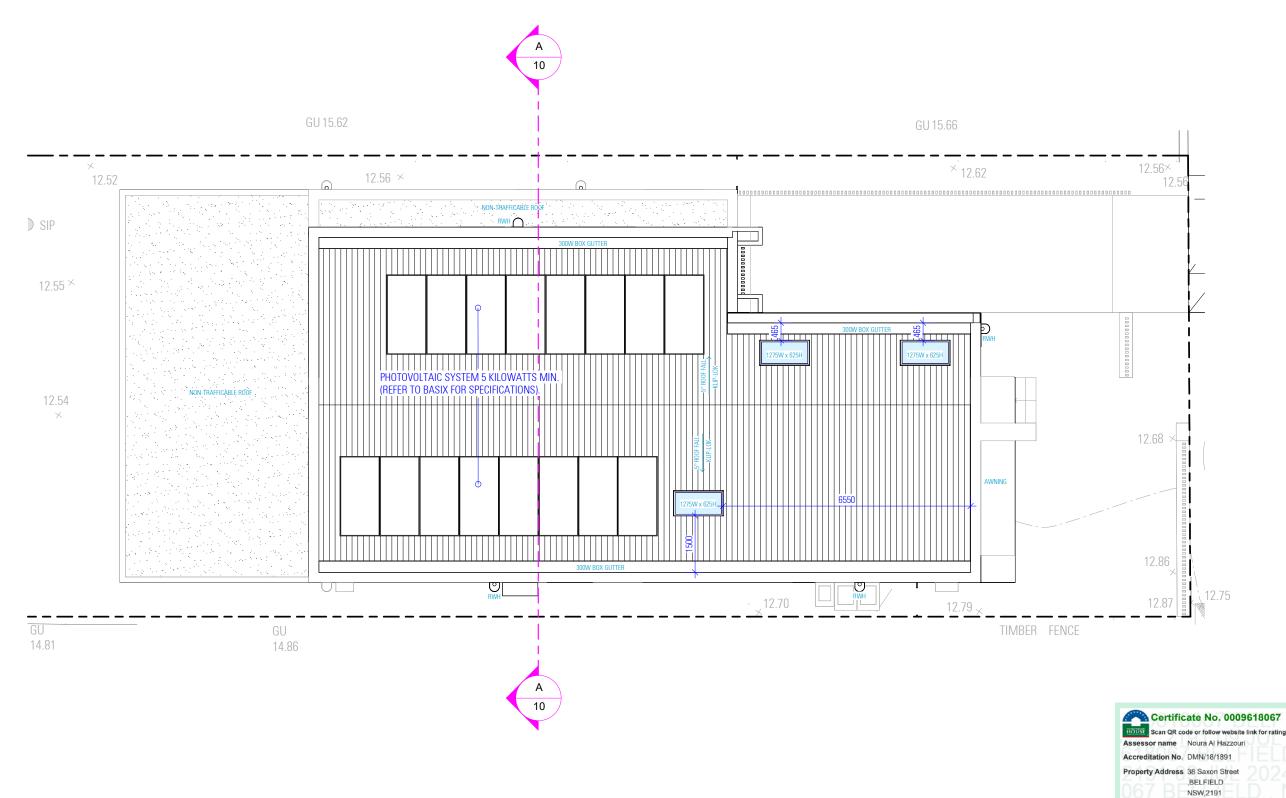

PROPOSED ROOF PLAN

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PROPOSED TWO STOREY DWELLING | DRAWING


PROPOSED ROOF PLAN


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DESIGN CLARE FAULKNER

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Scan QR code or follow website link for rating detail Assessor name Noura Al Hazzouri

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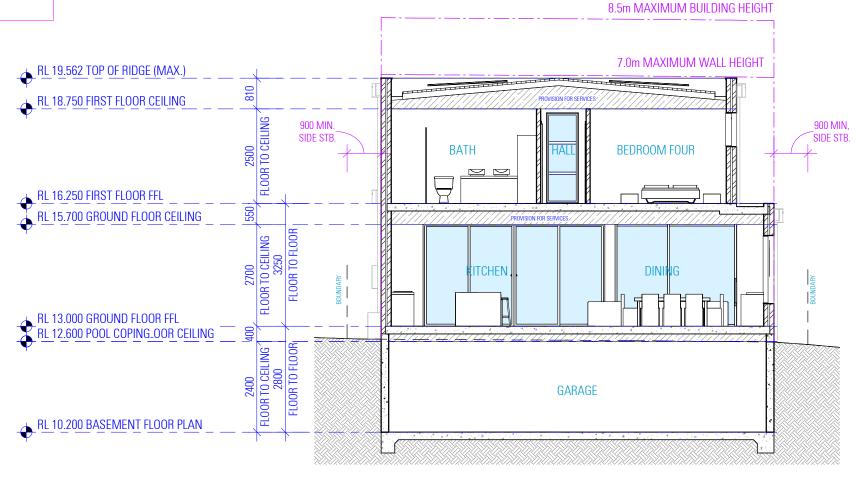
BELFIELD

NSW.2191 star.com.au/QR/Generate?p=rzTYtxIUC

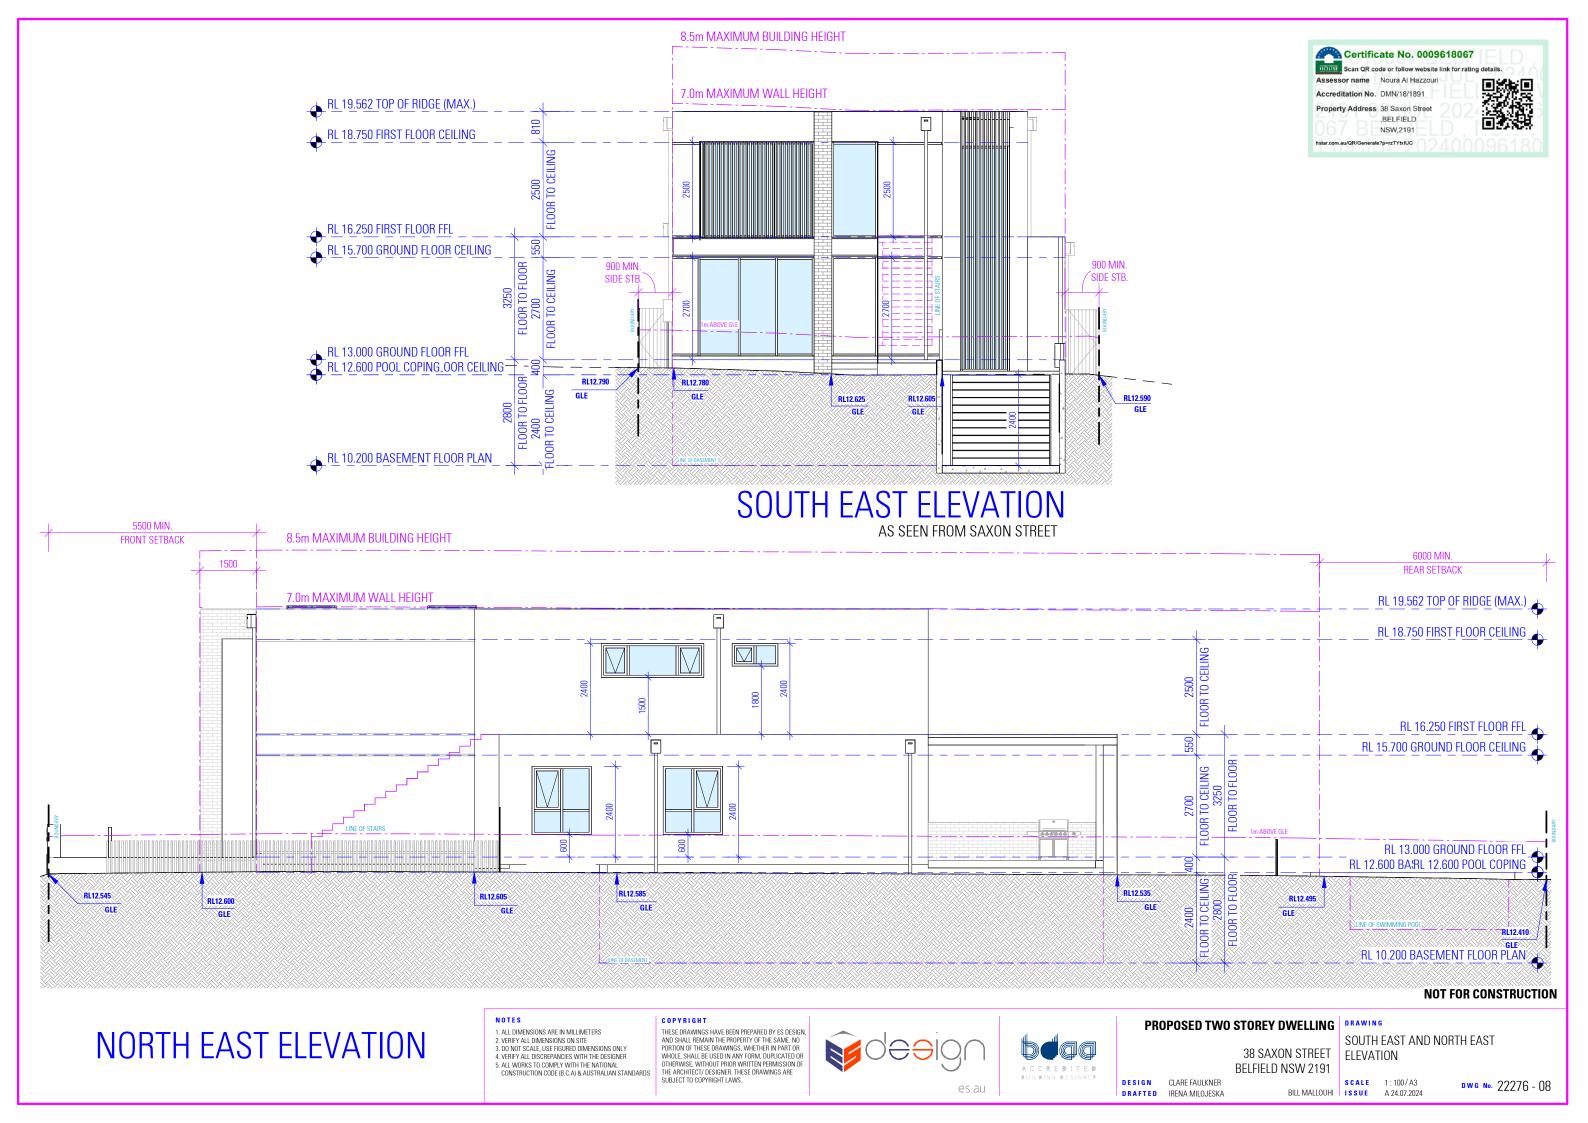1. THIS SCHEDULE DETAILS MAIN WALL COMPONENTS ONLY AND THE MEASUREMENTS GIVEN DO NOT INCLUDE RENDER, PLASTER OR THE LIKE. THEY ARE PROVIDED FOR 'CONSTRUCTION' PURPOSES AND SUCH DO NOT REPRESENT THE FINAL WALL THICKNESS.

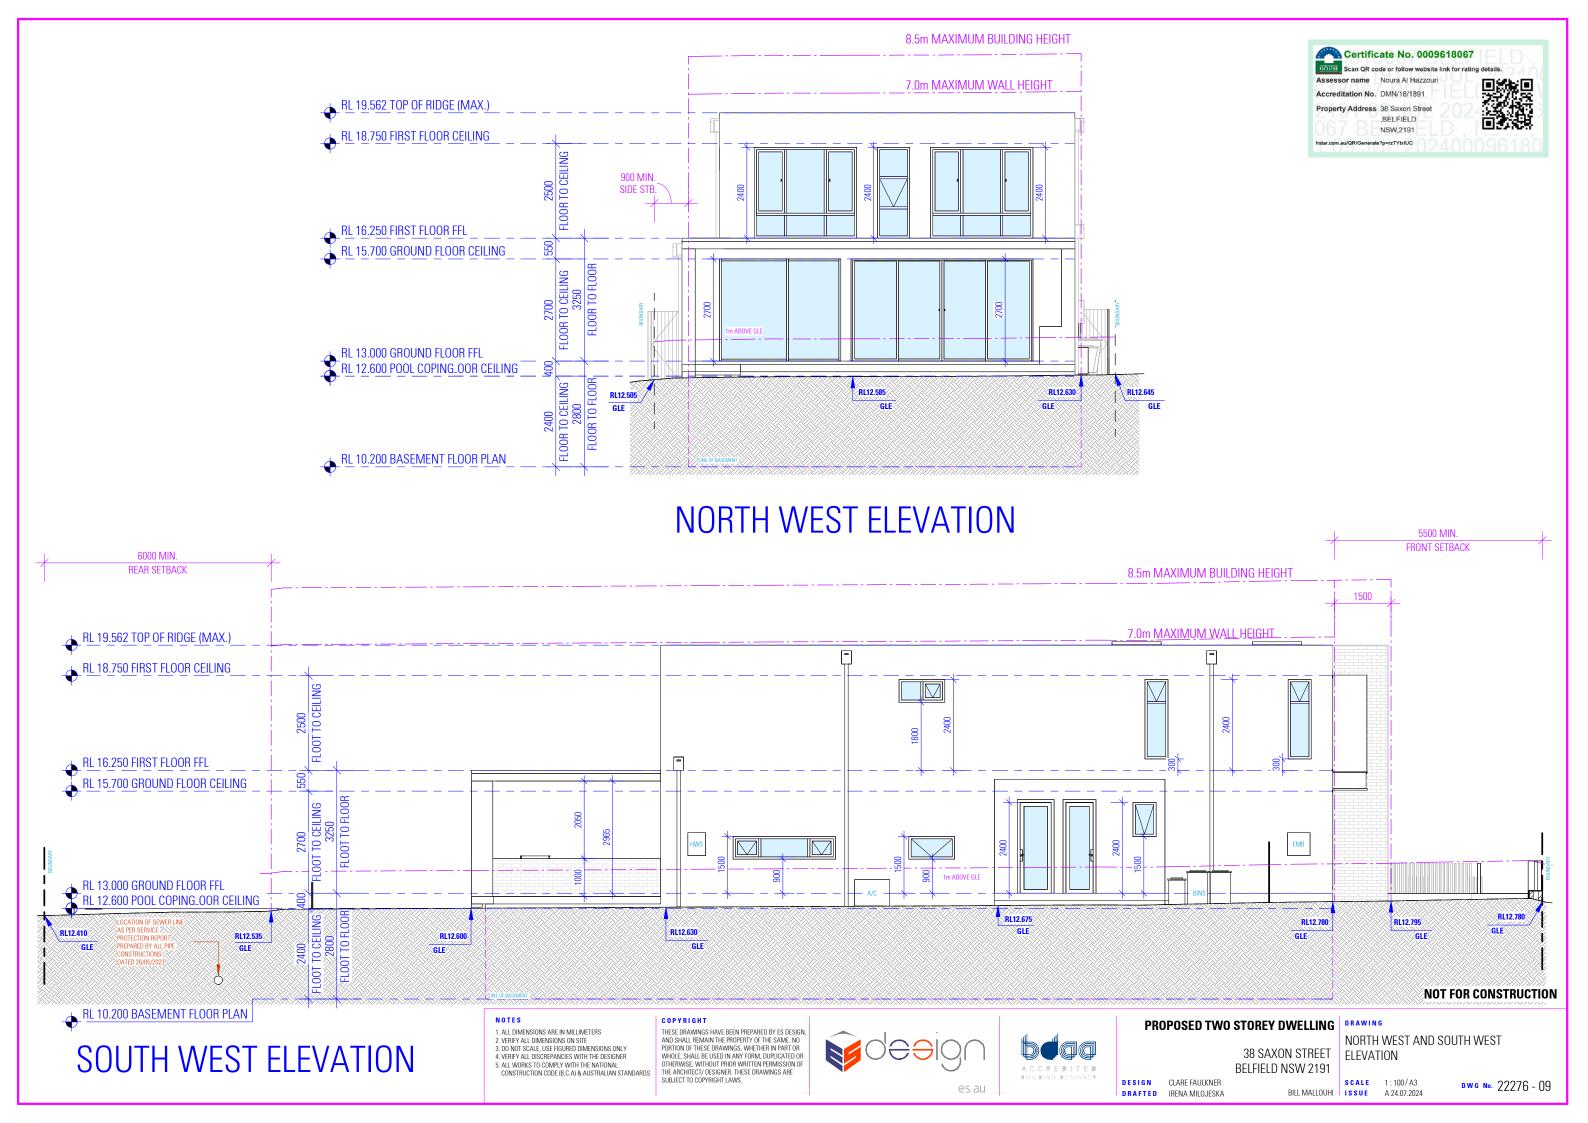3. THE ITEMS PROVIDED ABOVE ARE A GENERAL LIST OF WALL TYPES. VERIFY ALL DISCREPANCIES

4. REFER TO BASIX CERTIFICATE FOR INSULATION REQUIREMENTS



NATIONAL CONSTRUCTION CODE (NCC) EARTHWORKS AND EXCAVATIONS ARE TO BE CARRIED OUT IN ACCORDANCE WITH BCA 2022 H1D3 AND HOUSING PROVISIONS PART 3.2

- POWDER COATED ALUMINIUM GUTTERS & DOWNPIPES REFER TO STORMWATER PLAN FOR ALL SITE DRAINAGE
- DETAILS AND CALCULATIONS. NATIONAL CONSTRUCTION CODE (NCC)

COMPLY WITH BCA 2022 H1D7 AND H2D6

- DRAINAGE IS TO BE IN ACCORDANCE WITH BCA 2022 H2D2 ROOF, WALL CLADDING, GUTTERS & DOWNPIPES ARE TO
- TERMITE PROTECTION
 NATIONAL CONSTRUCTION CODE (NCC)
- PROTECTION MUST BE IN ACCORDANCE WITH BCA 2022 H1D3 AND ABCB HOUSING PROVISIONS PART 3.4
- FOOTINGS AND SLABS

 PROPOSED FOOTINGS TO THE SPECIFICATIONS OF A QUALIFIED
- PRACTISING FNGINFFR
- NATIONAL CONSTRUCTION CODE (NCC) FOOTINGS AND SLABS ARE TO BE DESIGNED AND
- AUSTRALIAN STANDARD (AS)
- PILED FOOTINGS ARE TO COMPLY WITH AS 2159-2009

 PROPOSED FLOOR CONSTRUCTION TO THE SPECIFICATIONS OF A QUALIFIED PRACTISING ENGINEER. ALL PORCHES, VERANDAHS & THE LIKE TO HAVE A 85mm STEPDOWN FROM INTERNAL AREAS UNLESS NOTED OTHERWISE

- FOR ALL REDUCED LEVELS REFER TO FLOOR PLANS (ENGINEERS DETAILS TO SUPERSEED-CONFIRM WITH DESIGNER)
- SUB FLOOR VENTILATION IS TO COMPLY WITH BCA 2022 H2D5

- NATIONAL CONSTRUCTION CODE (NCC)
- STEEL AND TIMBER FRAMING AND STRUCTURAL STEEL SECTIONS ARE TO COMPLY WITH BCA 2022 H1D6 MASONRY, MASONRY COMPONENTS AND ACCESSORIES, AND WEATHERPROOFING OF MASONRY ARE TO COMPLY
- WITH BCA 2022 H1D5 AND H2D4 . SOUND INSULATION IS TO BE IN ACCORDANCE WITH BCA
- 2022 H4D8
- REINFORCED AUTOCLAVED AERATED CONCRETE IS TO COMPLY WITH AS 5146.1-2015
- CONCRETE POST-INSTALLED AND CAST-IN FASTENINGS IS TO COMPLY WITH SA TA 101
- ROOF AND WALL CLADDING ARE TO COMPLY WITH BCA 2022

STRUCTURE

NATIONAL CONSTRUCTION CODE (NCC)

- STAIR CONSTRUCTION IS TO COMPLY WITH PART 3.9.1 STRUCTURAL DESIGN TO BE IN ACCORDANCE WITH ACCEPTABLE CONSTRUCTION MANUALS AS LISTED IN PART
- ATTACHMENT OF FRAMED DECKS AND BALCONIES TO EXTERNAL WALLS OF BUILDINGS USING A WALING PLATE IS TO COMPLY WITH BCA 2022 H1D11

EXTERNAL WATERPROOFING NATIONAL CONSTRUCTION CODE (NCC)

EXTERNAL WATERPROOFING IS TO COMPLY WITH BCA 2022

- POWDER COATED ALUMINIUM FRAMED GLASS WINDOWS & DOORS LINLESS NOTED OTHERWIS
- NATIONAL CONSTRUCTION CODE (NCC) ALL GLAZING IS TO BE IN ACCORDANCE WITH BCA 2022 H1D8 AND H2D7

NATIONAL CONSTRUCTION CODE (NCC)

ROOF CLADDING SHALL BE CARRIED OUT IN ACCORDANCE

AUSTRALIAN STANDARD (AS)

. DESIGN & INSTALLATION OF SHEET ROOF & WALL CLADDING

- NATIONAL CONSTRUCTION CODE (NCC)

 THE FIRE HAZARD PROPERTIES OF MATERIALS ARE TO COMPLY
- WITH BCA 2022 H3D2
 FIRE SEPARATION OF EXTERNAL WALLS IS TO COMPLY WITH

FIRE PROTECTION OF SEPARATING WALLS AND FLOORS IS TO

SECTION

- COMPLY WITH BCA 2022 H3D4 FIRE SEPARATION OF GARAGE-TOP-DWELLINGS IS TO COMPLY
- SMOKE ALARMS AND EVACUATION LIGHTING ARE TO COMPLY WITH BCA 2022 H3D6

HEALTH & AMENITY

- ALL BATHROOM, ENSUITES AND LAUNDRIES TO HAVE FLOOR WASTES AND BE SETDOWN AND WATERPROOFED.
- NATIONAL CONSTRUCTION CODE (NCC)
- WET AREAS ARE TO COMPLY WITH BCA 2022 H4D2 MATERIALS AND INSTALLATION OF WET AREA COMPONENTS
- AND SYSTEMS ARE TO COMPLY WITH BCA 2022 H4D3 ROOM HEIGHTS ARE TO COMPLY WITH BCA 2022 H4D4
- PROVISION OF LIGHT IS TO COMPLY WITH BCA 2022 H4D6
 PROVISION OF VENTILATION IS TO COMPLY WITH BCA 2022
- SOUND INSULATION IS TO COMPLY WITH BCA 2022 H4D8 CONDENSATION MANAGEMENT IS TO COMPLY WITH BCA

SAFE MOVEMENT & ACCESS NATIONAL CONSTRUCTION CODE (NCC)

- STAIRWAY AND RAMP CONSTRUCTION ARE TO COMPLY WITH
- BARRIERS AND HANDRAILS ARE TO COMPLY WITH BCA 2022
- THE WINDOW IS TO BE FITTED WITH EITHER A DEVICE TO RESTRICT THE WINDOW OPENING, OR A SUITABLE SCREEN, SO
- A 125mm SPHERE CANNOT PASS THROUGH.

 THE DEVICE OR SCREEN CAN HAVE A CHILD RESISTANT RELEASE MECHANISM (E.G. A KEY LOCK) WHICH CAN ENABLE THE DEVICE OR SCREEN TO BE REMOVED. UNLOCKED OR OVERRIDDEN. (SO FOR EXAMPLE, THE WINDOW CAN BE CLEANED)
- A BARRIER IS NOT REQUIRED FOR WINDOWS 1.7m OR MORE ABOVE THE FLOOR LEVEL.

EXTERNAL FINISHES• REFER TO SCHEDULE OF EXTERNAL MATERIALS, COLOURS AND FINISHES FOR MORE DETAILS.

ANCILLARY PROVISIONS AND ADDITIONAL CONSTRUCTION REQUIREMENTS

NATIONAL CONSTRUCTION CODE (NCC) • SWIMMING POOLS ARE TO COMPLY WITH BCA 2022 NSW

- CONSTRUCTION IN BUSHFIRE PRONE AREAS IS TO COMPLY
- WITH BCA 2022 NSW H7D4

 HEATING APPLIANCES, FIREPLACES, CHIMNEYS AND FLUES ARE TO COMPLY WITH BCA 2022 H7D5

LANDSCAPE• REFER TO LANDSCAPE PLAN FOR ALL PLANTING AND OUTDOOR SURFACE TREATMENTS

- THE RECOMMENDATIONS PROVIDED WITHIN THE BUSHFIRE ASSESSMENT REPORT ARE TO BE ADHERED TO. IN THE EVENT THAT THERE ARE INCONSISTENCIES, THE BUSHFIRE REPORT RECOMMENDATIONS ARE TO TAKE PRECEDENCE
- NATIONAL CONSTRUCTION CODE (NCC)
- BUSHFIRE AREAS ARE TO BE IN ACCORDANCE WITH BCA 2022

STRUCTURAL SOFTWARE USED IN COMPUTER AIDED DESIGN OF A BUILDING OR STRUCTURE THAT USES DESIGN CRITERIA BASED ON THE DEEMED-TO-SATISFY PROVISIONS OF NCC VOLUME TWO AND THE ABCB HOUSING PROVISIONS. INCLUDING ITS REFERENCED DOCUMENTS, FOR THE DESIGN OF STEEL OR TIMBER TRUSSED ROOF AND FLOOR SYSTEMS AND FRAMED BUILDING SYSTEMS, MUST COMPLY WITH THE ABCB PROTOCOL FOR STRUCTURAL SOFTWARE WHERE RELEVANT, AS REFERRED TO IN ABCB HOUSING

THE DEVELOPMENT HAS BEEN DESIGNED TO BEST MEET THE GUIDELINES OF COUNCIL & THE NATIONAL

(ALL WORK ON SITE SHALL BE CARRIED OUT IN A SIMILAR MANNER TO ADHERE TO THE REQUIREMENTS OF COUNCIL

MINOR CHANGES TO BUILDING FORM AND CONFIGURATION MAY BE REQUIRED WHEN DRAWINGS ARE SUBSEQUENTLY PREPARED FOR CONSTRUCTION PURPOSES AFTER THE GRANT OF DEVELOPMENT CONSENT

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Α 04-07



PROPOSED TWO STOREY DWELLING DRAWING

38 SAXON STREET

BELFIELD NSW 2191


SECTION VIEW

DWG No. 22276 - 10

DESIGN CLARE FAULKNER IRENA MILOJESKA

BILL MALLOUHI ISSUE

FRONT FENCE DETAILS

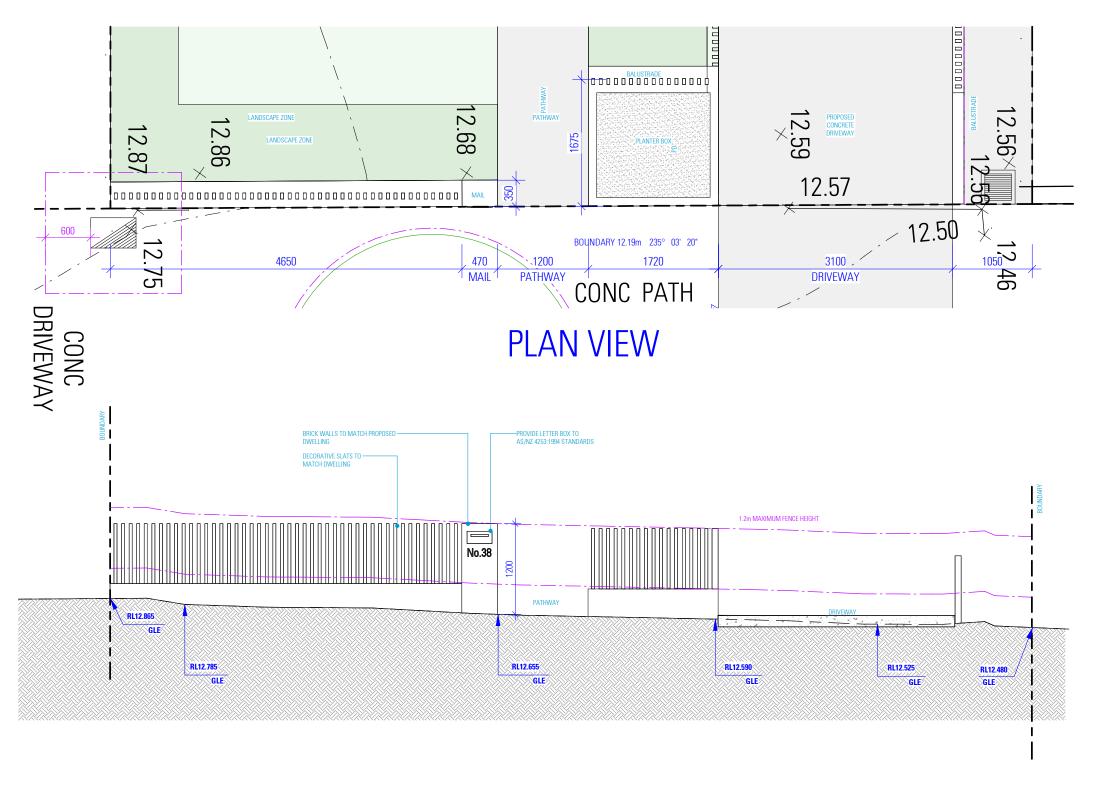

SOUTH EAST ELEVATION

AS SEEN FROM SAXON STREET

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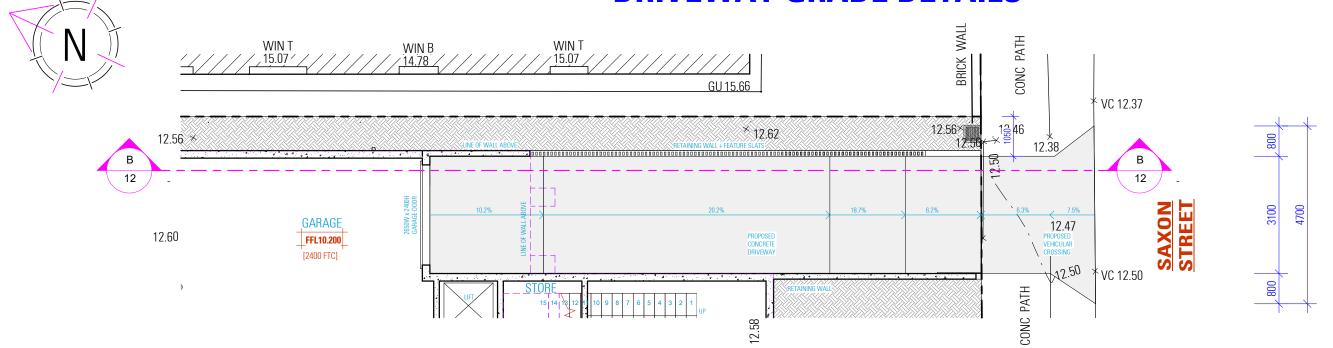
PROPOSED TWO STOREY DWELLING | DRAWING 38 SAXON STREET

BELFIELD NSW 2191 DESIGN CLARE FAULKNER


FRONT FENCE DETAILS

SCALE 1:50 /A3 DWG No. 22276 - 11 BILL MALLOUHI ISSUE

DRIVEWAY GRADE DETAILS



PLAN VIEW

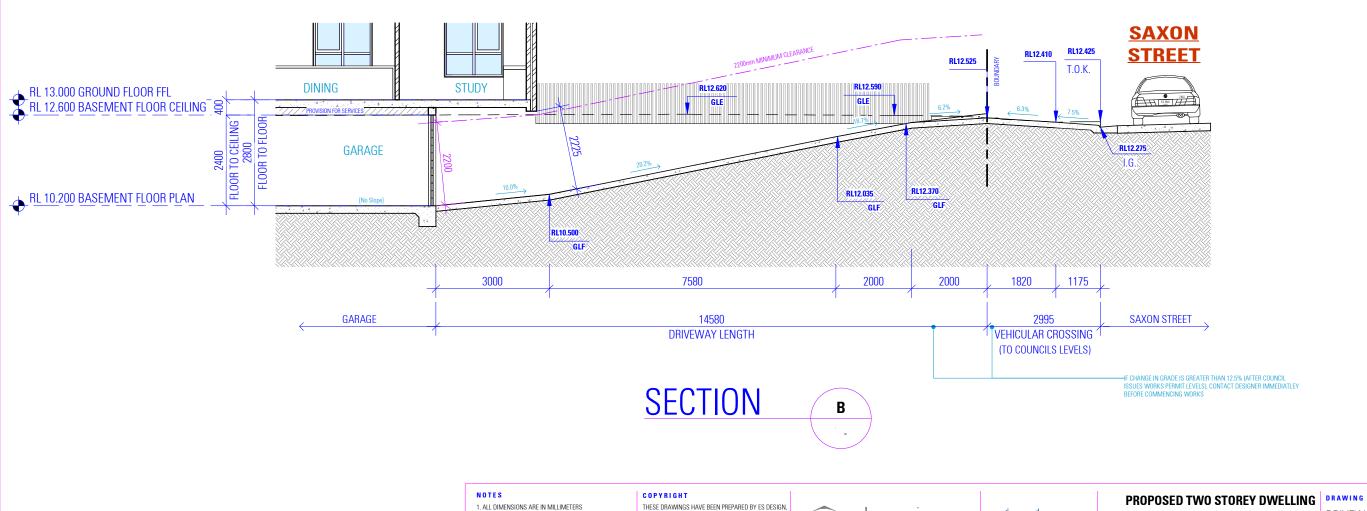

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38 SAXON STREET **BELFIELD NSW 2191** DESIGN CLARE FAULKNER

DRIVEWAY GRADE DETAILS

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SCHEDULE OF EXTERNAL MATERIALS, COLOURS AND FINISHES



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PROPOSED TWO STOREY DWELLING DRAWING

38 SAXON STREET **BELFIELD NSW 2191**

SCHEDULE OF EXTERNAL MATERIALS, COLOURS AND FINISHES


DWG No. 22276 - 13

DESIGN CLARE FAULKNER

BILL MALLOUHI ISSUE A 24.07.2024

SHADOW DIAGRAMS - 21st JUNE 39.6 VEHICULAR CROSSING STREET SAXON STREET **SHADOW DIAGRAM 8AM** SHADOW DIAGRAM 12PM SHADOW DIAGRAM 4PM COPYRIGHT PROPOSED TWO STOREY DWELLING DRAWING C O PYRIGHT THESE DRAWINGS HAVE BEEN PREPARED BY ES DESIGN, AND SHALL REMAIN THE PROPERTY OF THE SAME. NO PORTION OF THESE DRAWINGS, WHETHER IN PART OR WHOLE, SHALL BE USED IN ANY FORM, DUPLICATED OR OTHERWISE, WITHOUT PRIOR WRITTEN PERMISSION OF THE ARCHITECT/ DESIGNER. THESE DRAWINGS ARE SUBJECT TO COPYRIGHT LAWS. 1. ALL DIMENSIONS ARE IN MILLIMETERS 1. ALL DIMENSIONS ARE IN MILLIME LEHS 2. VERIFY ALL DIMENSIONS ON SITE 3. DO NOT SCALE, USE FIGURED DIMENSIONS ONLY 4. VERIFY ALL DISCREPANCIES WITH THE DESIGNER 5. ALL WORKS TO COMPLY WITH THE NATIONAL CONSTRUCTION CODE (B.C.A.) & AUSTRALIAN STANDARDS **Solution** SHADOW DIAGRAMS - 21st JUNE 38 SAXON STREET **BELFIELD NSW 2191** DESIGN CLARE FAULKNER SCALE 1:200/A3 DWG No. 22276 - 14 BILL MALLOUHI ISSUE

IN-GROUND SWIMMING POOL DETAILS

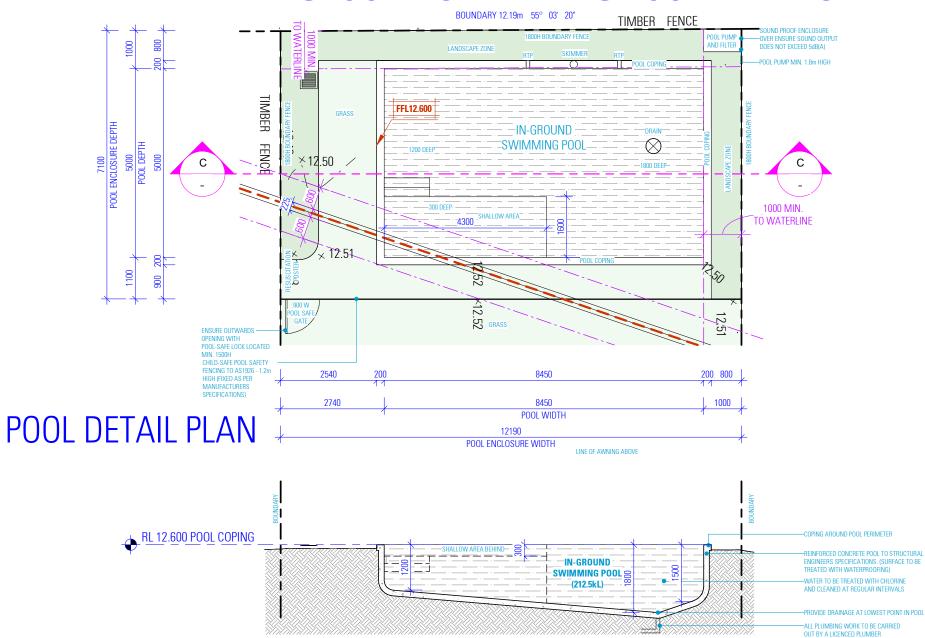



ALL POOLS MUST BE SEPARATED FROM RESIDENTIAL BUILDINGS AND ADJOINING PUBLIC OR PRIVATE PROPERTIES BY A COMPLYING CHILD-RESISTANT BARRIER (MUST BE IN ACCORDANCE WITH THE REGULATIONS AND AS1926.1-2012 SWIMMING POOL • DE IT WECONDAINGE WITH THE RESOLUTIONS AND ASTREE. PARTY SYMMINING TO SAFETY). NO DOOR ACCESS FROM A RESIDENTIAL BUILDING INTO AN OUTDOOR POOL IS PERMITTED ONLY STRUCTURES ASSOCIATED WITH THE POOL (FILTER HOUSING, ETC.) ARE PERMITTED WITHIN THE ENCLOSED POOL AREA STRUCTURES SUCH AS CLOTHES LINES, BARBEQUE, SHEDS, ENTERTAINMENT STRUCTURE, OUTSIDE TOILETS, ETC, MUST ALL BE LOCATED OUTSIDE THE CHILD RESISTANT BARRIER. SWIMMING POOL FENCING AND OTHER BARRIERS TO BE PROVIDED TO THE POOL AREA IN ACCORDANCE WITH THE SWIMMING POOLS ACT 1992. BOUNDARY FENCE TO BE 1.8m IN HEIGHT, MEASURED FROM INSIDE OF THE FENCING. POOL GATES SWIMMING POOL FENCING TO BE AT LEAST 1.2m HIGH, MEASURED ON THE OUTSIDE OF THE FENCING. MINIMUM 900mm SEPARATION BETWEEN THE UPPER AND LOWER HORIZONTAL MEMBERS TO MAINTAIN NON-CLIMBABLE ZONE HORIZONTAL MEMBERS OF THE FENCE SHOULD BE PLACED ON THE INSIDE OF THE FENCE AND BE AT LEAST 900mm APART.

THE SPACING OF VERTICAL MEMBERS OF THE FENCE SHALL NOT EXCEED

THE HEIGHT OF ANY OPENING BETWEEN THE BOTTOM OF THE FENCE AND

THE HEIGHT OF ANY OPENING BETWEEN THE BOTTOM OF THE FENCE AND FINISHED GROUND LEVEL SHALL NOT EXCEED TOOM.

ALL SWIMMING POOL FENCING TO BE MAINTAINED IN A GOOD CONDITION (ie. WITH NO HOLES, BROKEN OR LOOSE PALINGS).

NON-CLIMBABLE ZONE EXTENDS FROM THE POOL FENCE 300mm INTO THE POOL AREA AND 900mm OUTSIDE THE POOL AREA. TO PREVENT A CHILD TO CLIMB OVER THE FENCE, CLIMBABLE DOSLECTS SUCH AS BARBEOUSE, FURNITURE, PLANTER BOXES, TREES OR SHRUB ARE NOT PERMITTED WITHIN THIS NON-CLIMBABLE TO CLIMBABLE TO THE POOL AREA ON THE PROVINCE THE PLANTER BOXES. TREES OR SHRUB ARE NOT PERMITTED WITHIN THIS NON-CLIMBABLE TO THE PROVINCE THE POOL AREA ON THE PROVINCE THE POOL AREA OF THE POOL

CLIMBARIE ZONE
IF THE WALL OF THE HOUSE FORMS PART OF THE APPROVED CHILD-RESISTANT
BARRIER TO THE POOL AREA (ie. IN RELATION TO POOLS INSTALLED BEFORE)
AUGUST 1990), ALL DOOR AND WINDOW OPENINGS IN THE WALL/S MUST BE
CHILD-RESISTANT IN ACCORDANCE WITH THE REGULATIONS TO PREVENT
CHILDREN ACCESSING THE POOL AREA.

GATES TO THE SWIMMING POOL AREA ARE TO OPEN OUTWARDS AND ARE TO BE FULLY SELF-CLOSING AND SELF-LATCHING FROM ANY OPEN POSITION. NO DOUBLE GATES ARE PERMITTED GATES ARE NOT TO BE PROPPED OPEN AT ANY TIME.

THE LATCHING DEVICE TO THE POOL GATE IS TO BE LOCATED A MINIMUM 1.5m ABOVE GROUND LEVEL AND 1.4m FROM THE HIGHEST LOWER HORIZONTAL BARRIER MEMBER OR, ALTERNATIVELY, THE DEVICE IS TO BE LOCATED INSIDE THE GATE AND THE LATCHING DEVICE IS TO BE PROPORHATELY SHIELDED FROM THE GATE AND THE LATCHING DEVICE IS TO BE ACCURDING CLAUSE 28 OF THE STANDARD) TO ENSURE THE LATCHING DEVICE IS ONLY ACCESSIBLE BY REACHING OVER THE GATE.

GATE WIDTH IS TO BE KEPT TO A MINIMUM (NO MORE THAN 1 METRE) TO DROP WITH THE SELF-LATCHING MECHANISM FAILING.

SPA POOLS ARE ALSO COVERED BY THE LEGISLATION AND SHOULD BE SEPARATED BY A CHILD-RESISTANT POOL SAFETY BARRIER IN ACCORDANCE WITH AUSTRALIAN STANDARD AS1926.1-2012.
ALTERNATIVELY, THE SPA POOL MUST BE COVERED AND SECURED BY A LOCKABLE CHILD-SAFE STRUCTURE (SUCH AS A DOOR, LID, GRILLE OR MESH).
SUCH LOCKABLE STRUCTURE MUST BE ABLE TO BE REMOVED/INSTALLED AND

RESUSCITATION WARNING SIGN

AN APPROPRIATE RESUSCITATION WARNING SIGN (AVAILABLE FROM COUNCIL
OR THE ROYAL LIFE SAVING SOCIETY IS DISPLAYED IN A PROMINANT POSITION
IN THE IMMEDIATE VICINITY OF THE POOL AREA.

THE FOLLOWING WARNING STATEMENTS MUST BE CONTAINED WITHIN THE

Certificate No. 0009618067

BELFIELD

NSW.2191

Assessor name Noura Al Hazzouri

Accreditation No. DMN/18/1891 Property Address 38 Saxon Street

hstar.com.au/QR/Generate?p=rzTYtxIUC

YOUNG CHILDREN SHOULD BE SUPERVISED WHEN USING

 YOUNG CHILDREN SHOULD BE SUPFIVISED WHEN USING
 THIS SWIMMING POOL
 POOL GATES MUST BE KEPT CLOSED AT ALL TIMES
 KEPP ATTICLES, OBJECTS AND STRUCTURES AT LEAST 900
 MM CLEAR OF THE POOL FENCE AT ALL TIMES
 THE RESUSCITATION SIGN MUST BE:
 LEGIBLE FROM A DISTANCE OF AT LEAST THREE METRES
 MAINTAINED IN A CLEARLY LEGIBLE CONDITION
REFER TO THE SWIMMING POOLS ACT 1992. THE SWIMMING POOLS REGULATION 2018 AND
ALISTRALM STANDARD AS 1992 1 2012 FOR THE SWIMMING POOLS REGULATION 2018 AND
ALISTRALM STANDARD AS 1992 1 2012 FOR THE SWIMMING POOLS OF A CANDARD LOG A AUSTRALIAN STANDARD AS 1926-1-2012 (EXCLUDING CLAUSE 2.8 OF THE STANDARD) FOR A COMPLETE LIST OF REQUIREMENTS.

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PROPOSED TWO STOREY DWELLING | DRAWING

38 SAXON STREET


BELFIELD NSW 2191

IN-GROUND SWIMMING POOL DETAILS

SCALE 1:100/A3


DESIGN CLARE FAULKNER DRAFTED IRENA MILOJESKA

BILL MALLOUHI ISSUE

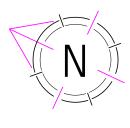

- REFER TO LANDSCAPE PLAN FOR DETAILS
- REFER TO STORMWATER PLAN FOR STORMWATER DETAILS / SEDIMENT AND EROSION CONTROL PLAN
- REFER TO STRUCTURAL PLAN FOR RETAINING WALL DETAILS • REFER TO STORMWATER PLAN AND BASIX REPORT FOR RAINWATER TANK DETAILS
- ALL BOUNDARY FENCING TO BE MAINTAINED OR CONSTRUCTED AT A HEIGHT OF 1800mm ABOVE NGL

SITE CALCULATION	VS
SITE AREA	483.1 sqm
GROUND FLOOR AREA	131.24sqm
FIRST FLOOR AREA	115.76sqm
TOTAL FLOOR AREA	247.00sqm
FLOOR SPACE RATIO	0.51:1
MAX FLOOR SPACE RATIO	0.55:1
SITE COVERAGE	215.83 sqm
MAX SITE COVERAGE (50%)	241.55sqm
IMPERVIOUS AREA	338.43sqm
DEEP SOIL AREA	105.81sqm
MIN DEEP SOIL AREA 20%	96.62sqm

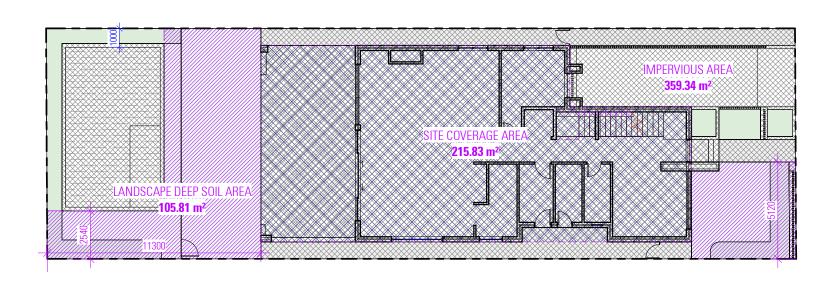

LANDSCAPE AREA CALCULATION PLAN

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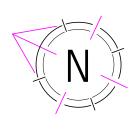
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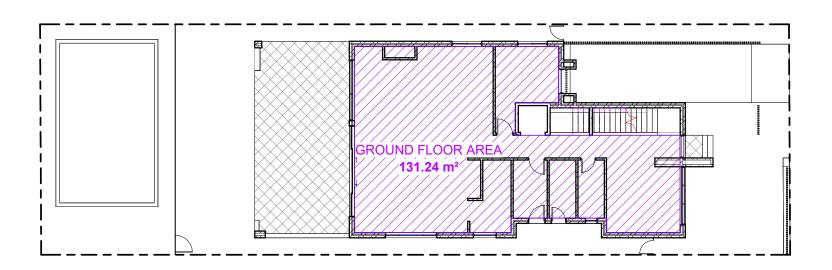
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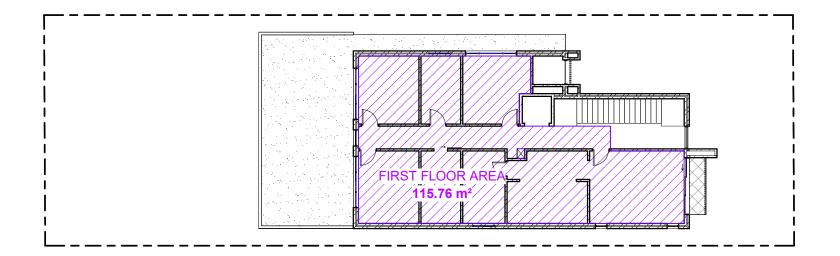
38 SAXON STREET

LANDSCAPE AREA CALCULATION SHEET

BELFIELD NSW 2191 BILL MALLOUHI ISSUE A 24.07.2024







- REFER TO LANDSCAPE PLAN FOR DETAILS
- REFER TO STORMWATER PLAN FOR STORMWATER DETAILS / SEDIMENT AND EROSION CONTROL PLAN
- REFER TO STRUCTURAL PLAN FOR RETAINING WALL DETAILS REFER TO STORMWATER PLAN AND BASIX REPORT FOR
- RAINWATER TANK DETAILS • ALL BOUNDARY FENCING TO BE MAINTAINED OR CONSTRUCTED AT A HEIGHT OF 1800mm ABOVE NGL

	SITE CALCULATION	VS
	SITE AREA	483.1 sqm
	GROUND FLOOR AREA	131.24sqm
	FIRST FLOOR AREA	115.76sqm
5	TOTAL FLOOR AREA	247.00sqm
	FLOOR SPACE RATIO	0.51:1
	MAX FLOOR SPACE RATIO	0.55:1
	SITE COVERAGE	215.83 sqm
	MAX SITE COVERAGE (50%)	241.55sqm
	IMPERVIOUS AREA	338.43sqm
	DEEP SOIL AREA	105.81sqm
	MIN DEEP SOIL AREA 20%	96.62sqm

GROUND FLOOR GFA

FIRST FLOOR GFA

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PROPOSED TWO STOREY DWELLING | DRAWING

38 SAXON STREET SHEET

BELFIELD NSW 2191

GROSS FLOOR AREA CALCULATION

DWG No. 22276 - 17

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PROPOSED TWO STOREY DWELLING | DRAWING

DESIGN CLARE FAULKNER

DRAFTED IRENA MILOJESKA

3D VIEWS 38 SAXON STREET

BELFIELD NSW 2191

BILL MALLOUHI SCALE /A3
BILL MALLOUHI ISSUE A 24.07.2024

BASIX COMMITMENTS

BASIX Certificate



Project name	38_sax	38_sax		
Street address	38 SAXON STREET BEI	38 SAXON STREET BELFIELD 2191		
Local Government Area	Canterbury-Bankstown C	Council		
Plan type and plan number	Deposited Plan 15621	Deposited Plan 15621		
Lot no.	16	16		
Section no.	-			
Project type	dwelling house (detache	dwelling house (detached)		
No. of bedrooms	4			
Project score				
Water	✓ 42	Target 40		
Thermal Performance	✓ Pass	Target Pase		
Energy	✓ 84	Target 72		
Materials	₩ .67	Target n/a		

Certifi	cate Prepared by
Name / C	Company Name: Noura Al Hazzouri
ABN (if a	pplicable): 80873399711

y 2024	page 1/10	BASIX	

		Insulation
floor - concrete slab on ground, conventional slab.	56	expanding foam
garage floor - concrete slab on ground.	130.3	expanding foam
external wall: cavity brick; frame: no frame.	197.8	foil-foam composite board
external wall: concrete block/plasterboard; frame: no frame.	130	none
external garage wall: concrete block/plasterboard; frame: no frame.	20	none
internal wall: single skin masonry; frame: no frame.	24	none
ceiling and roof - flat ceiling / flat roof, framed - metal roof, timber - H2 treated softwood.	165	ceiling: rockwool batts, roll or pump-in; roof: foil/sarking.

December of Discourse Manager and	 Married Ann LEWIS MARRIES AND ALL O	Continues No. (70,4000)	Tuesday 00 hds 2024	

Thermal Performance and Materials commitments		Show on DA plans	Show on CC/CDC plans & specs	Certifier check
Glazing				
The applicant must install windows, glazed doors and skylights as listed in the table.	described in the table below, in accordance with the specifications	~	~	-
	Maximum area - m2			
Frames	Maximum area - m2 80.9			
imber	0			
ePVC	0			
steel	0			
composite	0			
	<u> </u>			
Slazing	Maximum area - m2			
single	5.7			
double	75.2			
riple	0			

Water Commitments	Show on DA plans	Show on CC/CDC plans & specs	Certifier check
Fixtures			
The applicant must install showerheads with a minimum rating of 4 star (> 4.5 but <= 6 Limin plus spray force and/or coverage tests) in all showers in the development.		~	~
The applicant must install a tollet flushing system with a minimum rating of 4 star in each tollet in the development.		~	~
The applicant must install taps with a minimum rating of 5 star in the kitchen in the development.		~	
The applicant must install basin taps with a minimum rating of 5 star in each bathroom in the development.		~	
Alternative water			
Rainwater tank			
The applicant must install a rainwater tank of at least 2000 litres on the site. This rainwater tank must meet, and be installed in accordance with, the requirements of all applicable regulatory authorities.	~	~	~
The applicant must configure the rainwater tank to collect rain runoff from at least 80 square metres of the roof area of the development (excluding the area of the roof which drains to any stormwater tank or private dam).		~	~
The applicant must connect the rainwater tank to:			

Schedule of BASIX commitments

	a tap that is located within 10 metres of the swimming pool in the development.	~	-	
L				

Energy Commitments	Show on DA plans	Show on CC/CDC plans & specs	Certifi
Hot water			
The applicant must install the following hot water system in the development, or a system with a higher energy rating; gas instantaneous with a performance of 4 stars.	~	~	-
Cooling system			
The applicant must install the following cooling system, or a system with a higher energy rating, in at least 1 living area: 1-phase airconditioning - ducted; Energy rating: 3.5 star (average zone)		~	
The applicant must install the following cooling system, or a system with a higher energy rating, in at least 1 bedroom: 1-phase airconditioning - ducted; Energy rating: 3.5 star (average zone)		~	
Heating system			
The applicant must install the following heating system, or a system with a higher energy rating, in at least 1 living area: 1-phase airconditioning - ducted; Energy rating: 3.5 star (average zone)		~	
The applicant must install the following heating system, or a system with a higher energy rating, in at least 1 bedroom: 1-phase airconditioning - ducted; Energy rating: 3.5 star (everage zone)		~	٠,
Ventilation			
The applicant must install the following exhaust systems in the development:			
At least 1 Bathroom: individual fan, ducted to façade or roof; Operation control: manual switch on/off		~	١,
Kitchen: individual fan, ducted to façade or roof; Operation control: manual switch on/off		-	١,
Laundry: individual fan, ducted to façade or roof; Operation control: manual switch on/off		-	١,
Artificial lighting			
The applicant must ensure that a minimum of 80% of light fixtures are fitted with fluorescent, compact fluorescent, or light-emitting- diode (LED) lamps.		~	
Natural lighting			
The applicant must install a window and/or skylight in the kitchen of the dwelling for natural lighting.	-		Γ,

П	Artificial lighting			
	The applicant must ensure that a minimum of 80% of light futures are fitted with fluorescent, compact fluorescent, or light-emitting- diode (LED) lamps.		~	~
	Natural lighting			
	The applicant must install a window and/or skylight in the kitchen of the dwelling for natural lighting.	~	~	~

Water Commitments	Show on DA plans	Show on CC/CDC plans & specs	Certifier check
Swimming Pool			
The swimming pool must not have a volume greater than 63 kilolitres.	~	~	
The swimming pool must have a pool cover.		~	
The swimming pool must be outdoors.	~	~	

Swimming Pool			
The swimming pool must not have a volume greater than 63 kilolitres.	~	~	
The swimming pool must have a pool cover.		~	
The swimming pool must be outdoors.	~	~	

	DA plans	plans & specs
Simulation Method		
Assessor details and thermal loads		
The applicant must attach the certificate referred to under "Assessor Details" on the front page of this BASIX certificate (he "Assessor Cettals") as the first page of the BASIX certificate (he receited as placed evelopment application and construction certificate by the proposed development or the proposed development or applying development certificate for the proposed development, to that application). The applicant must also attach the Assessor Certificate to the application for an occupation certificate for the proposed development.		
The Assessor Certificate must have been issued by an Accredited Assessor in accordance with the Thermal Comfort Protocol.		
The details of the proposed development on the Assessor Certificate must be consistent with the details shown in this BASIX certificate, including the Cooling and Heating loads shown on the front page of this certificate and the "Construction" and "Glazing" abbles below.		
The applicant must show on the plans accompanying the development application for the proposed development, all matters which the Assessor Certificate requires but all how the Assessor to certify that this is the case. The applicant must alwo on the plans accompanying the application for a construction certificate (or complying development certificate, or application), all thermal preformance specifications set out in the Assessor Certificate, and all application that there were used to decidate these specifications are out in the Assessor Certificate, and all applicate of the proposed development which verture sude to decidate these specifications.	~	~
The applicant must construct the development in accordance with all thermal performance specifications set out in the Assessor Certificate, and in accordance with those aspects of the development application or application for a complying development certificate which were used to calculate those specifications.		~
The applicant must show on the plans accompanying the development application for the proposed development, the locations of ceiling fars set out in the Assessor Certificate. The applicant's must show on the plans accompanying the application for a construction certificate (or complying development certificate, if applicate), the locations of ceiling fines set out in the Assessor Certificate or constitutions are constructed as the certification of the certification of ceiling from set out in the Assessor Certificate or constitutions are certificated as the certification of the certifica	~	~

BASIX	Department of Planning, Housing and	www.basix.nsw.gov.au	Version: 4.03 / EUCALYPTUS_03_01_0	Certificate No.: 1754999S	Tuesday, 09 July 20

Energy Commitments	Show on DA plans	Show on CC/CDC plans & specs	Certifier check
The applicant must install a window and/or skylight in 4 bathroom(s)/toilet(s) in the development for natural lighting.	~	~	~
Swimming pool			
The development must not incorporate any heating system for the swimming pool.		~	
The applicant must install the following pump for the swimming pool in the development, or a pump with a higher energy rating: single speed with a performance of 2 stars.		~	
The applicant must install a timer for the swimming pool pump in the development.		~	
Alternative energy			
The applicant must install a photovoltaic system as part of the development. The applicant must connect this system to the development's electrical system.	~	~	~
The photovolatic system must consist of:			
 photovolatic collectors with the capacity to generate at least 5 peak kilowatts of electricity, installed at an angle between 0 degrees and 10 degrees to the horizontal facing north 	-	~	-
Other			
The applicant must install a gas cooktop & electric oven in the kitchen of the dwelling.		~	
The applicant must install a fixed outdoor clothes drying line as part of the development.			

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DESIGN CLARE FAULKNER


38 SAXON STREET

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BASIX COMMITMENTS

BILL MALLOUHI ISSUE A 24.07.2024

NATHERS COMMITMENTS

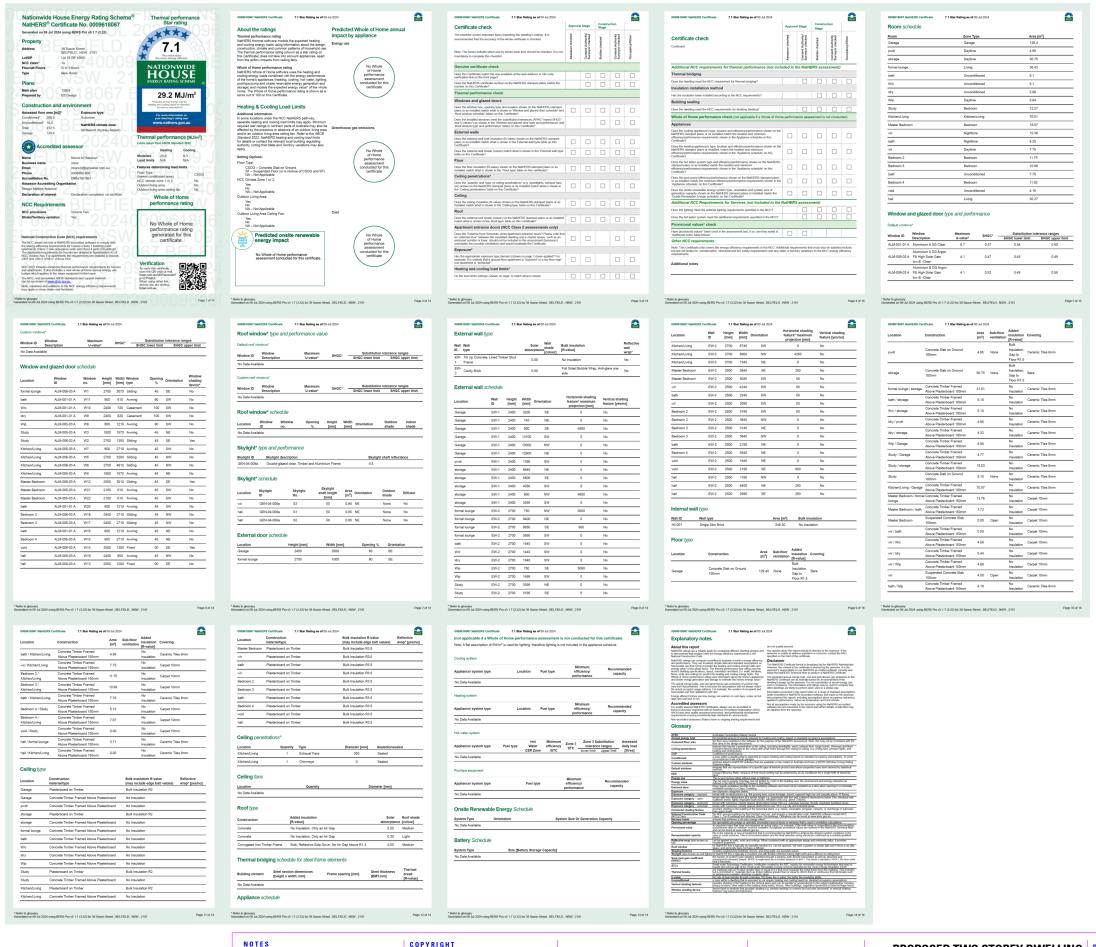

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